


KNOWLTON FARMS SOLAR DEVELOPMENT 43 ESTABROOK AVENUE [PILOT PROJECT]

ASSESSOR'S MAP 49 - LOT 1 -APPLICATION FOR SPECIAL PERMIT--APPLICATION FOR SITE PLAN APPROVAL-

PLANS AND DESIGN HAVE BEEN DEVELOPED IN ACCORDANCE WITH THE PERFORMANCE STANDARDS SET FORTH IN SECTION 4.1 OF THE GRAFTON ZONING BYLAW & ARTICLE 36: STORMWATER MANAGEMENT BYLAW

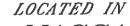

# GRAFTON, MASSACHUSETTS

DATE: JUNE 26, 2018 REVISED: JULY 19, 2018 REVISED: AUGUST 8, 2018

#### APPLICANT:

ESTABROOK VALLEY, LLC 111 HUNTINGTON AVENUE BOSTON, MASSACHUSETTS 02199

#### RECORD OWNERS:

KNOWLTON FARMS NOMINEE TRUST PATRICIA K. KNOWLTON, TRS. 43 ESTABROOK AVENUE GRAFTON, MASSACHUSETTS 01519

#### LAND SURVEYOR/SITE CIVIL ENGINEER:



AGS CENTER SUTTE 1910 49 MILK STREET, SUITE 3/23
MASSACHUSETTS 01915 WESTBOROUGH, MASSACHUSETTS 01501 ) 299-0441 TELEPHONE: (508) 871-7030 WWW.MERIDIANASSOC.COM

#### ENVIRONMENTAL CONSULTANT:



LEC ENVIRONMENTAL CONSULTANTS, INC. 100 GROVE STREET, SUITE 302 WORCESTER, MA 01605 TEL: (508) 753-3077 FAX: (508) 753-3177 WWW.LECENVIRONMENTAL.COM

### RECEIVED

AUG 9 2018

PLANNING BOARD GRAFTON, MA

#### LOCUS CONTEXT MAP:

GRAPHIC SCALE SCALE: 1"-500"

### PROJECT SUMMARY:

THE PROJECT PROPOSES THE INSTALLATION OF 210
TABLES EACH CONTAINING 4 SOLAR PANELS FOR A
TOTAL OF 840 SOLAR PANELS. THE SOLAR PANELS
WILL BE INSTALLED AS AN ELEVATED CANOPY THAT
WILL ALLOW AGRICULTURAL ACTIVITIES NAMELY, A
COMBINATION OF LIGHT LIVESTOCK AND FOOD CROPS
TO CONTINUE UNIMPEDED UNDER THE ARRAY (I.E. DUAL-USE"). THE SOLAR ENERGY FACILITY WILL PRODUCE APPROXIMATELY 331 KILOWATTS DC (KWDC) OF POWER, AND 250 KILOWATTS AC (KWAC) OF POWER.

#### DRAWING INDEX:

COVER SHEET & LOCUS CONTEXT MAP SHEET 1

SHEET 2 RECORD CONDITIONS PLAN SHEET 3 PERMIT SITE PLAN OF LAND

SEDIMENT AND EROSION CONTROL DETAILS SHEET 4

SHEET 5 SITE DETAILS




APPROVED BY: GRAFTON PLANNING BOARD

# **EXHIBIT** 9

"THIS PLAN IS SUBJECT TO A SPECIAL PERMIT DATED \_\_\_\_ "THIS PLAN IS SUBJECT TO SITE PLAN APPROVAL DATED \_

"THIS PLAN IS SUBJECT TO A CERTIFICATE OF OF GOOD STANDING DATED JUNE 21, 2018"

FOR PERMITTING ONLY. NOT FOR CONSTRUCTION

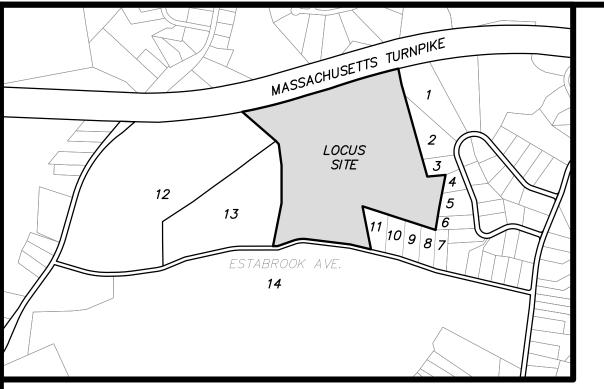

#### LOCUS MAP: (SCALE: 1"=1000')

# ABUTTER INFORMATION:

MAP 41/LOT 104 - JOSEPH DIROBERTO (23 VALLEY VIEW DRIVE) . MAP 41/LOT 103 — RICHARD URELLA (21 VALLEY VIEW DRIVE) MAP 41/LOT 102 - STEVE SARDELLA (19 VALLEY VIEW DRIVE) 4. MAP 41/LOT 101 - FARID THANAWALLA (17 VALLEY VIEW DRIVE) 5. MAP 50/LOT 16 - MARTIN URBAN (15 VALLEY VIEW DRIVE) 6. MAP 50/LOT 15 - YONGHUA GIA (13 VALLEY VIEW DRIVE) MAP 50/LOT 3F - WILLIAM MCNALLY (63 ESTABROOK AVENUE) 8. MAP 49/LOT 5 - CAROL WAHLGREN (61 ESTABROOK AVENUE) 9. MAP 49/LOT 4 - STEPHEN GOODSPEED (59 ESTABROOK AVENUE) 10. MAP 49/LOT 3 - KIM LORNA CHISSON (57 ESTABROOK AVENUE)

11. MAP 49/LOT 2 - WALDO SIMPSON (55 ESTABROOK AVENUE)

12. MAP 48/LOT 12 - TOWN OF GRAFTON (48 OLD WESTBORO ROAD)

<u>LLOLIND:</u>				
—————————————————————————————————————	TWO FOOT CONTOUR TEN FOOT CONTOUR SPOT ELEVATION BORDERING VEGETATIVE WETLANDS			
+WF C2	WETLAND FLAG			
	- LIMIT OF BUFFER ZONE			
	TREE LINE			
	STONE WALL			
00 000 00	STONE WALL REMAINS			
	STOCKADE FENCE			
	- CHAINLINK FENCE			
	GRAVEL ACCESS			
<del>-</del>	- DRAIN LINE			
OHW	OVERHEAD WIRES			
	GUY WIRE			
	TERMINUS UNKNOWN			
<del>-</del>	UTILITY POLE			
<i>∐EHH</i>	ELECTRICAL HAND HOLE			
TYP.	TYPICAL			
EOP	EDGE OF PAVEMENT			
CONC.	CONCRETE			
ELEV.	ELE VA TION			
<i>AC</i> .	ACRES			
S.F.	SQUARE FOOT			
IN V.	INVERT			
L=	LENGTH			
CLF	CHAIN LINK FENCE			

### NOTES:

1. THE TOPOGRAPHY, SITE DETAIL & SURFACE IMPROVEMENTS DEPICTED HEREON WERE OBTAINED FROM AN INSTRUMENT SURVEY CONDUCTED ON THE GROUND BY MERIDIAN ASSOCIATES, INC. ON JUNE 5, 2018 AND SUPPLEMENTED WITH DATA FROM AUGUST 22, 2016, JULY 9, 2013 TO AUGUST 20, 2013 AND MAY 27, 2014 TO JULY 18, 2014.

CONCRETE BLOCK RETAINING WALL

- 3. THE SUBJECT PROPERTY IS DEPICTED AS LOT 1 ON THE TOWN OF GRAFTON ASSESSOR'S MAP
- 4. THE LOCATION OF ALL UNDERGROUND UTILITIES SHOWN ARE APPROXIMATE AND ARE BASED UPON A PARTIAL FIELD SURVEY AND COMPILATION OF PLANS OF RECORD. MERIDIAN ASSOCIATES, INC. DOES NOT WARRANTY NOR GUARANTEE THE LOCATION OF ALL UTILITIES
- 7. HORIZONTAL DATUM IS THE MASSACHUSETTS STATE PLANE COORDINATE SYSTEM (NAD83) AS
- 8. PROPERTY LINES DEPICTED HEREON ARE BASED ON COMPILED DEEDS AND PLANS OF RECORD. THIS PLAN IS NOT TO BE USED FOR THE RECONSTRUCTION OF BOUNDARY LINES OR FOR TITLE INSURANCE PURPOSES. ALL BOUNDARY LINES DEPICTED ARE APPROXIMATE ONLY. MAI DID NOT PERFORM A BOUNDARY RETRACEMENT SURVEY.
- ON APRIL 1, 2013 AND MOST RECENTLY JUNE 6, 2014.
- 10. THE SOIL BORINGS DEPICTED HEREON WERE PERFORMED BY YOUNGMIN CHO, PhD, GEOLOGIST,
- 11. THE SUBJECT PROPERTY IS LOCATED IN FLOOD ZONE X (UNSHADED), AREAS DETERMINED TO BE OUTSIDE THE 0.2% ANNUAL CHANCE FLOODPLAIN, PÈR FEMA FLOOD INSURANCE RATE MAP NUMBER 25027C0831E DATED JULY 4, 2011.
- 12. THE SUBJECT SITE IS LOCATED WITHIN THE MISCOE, WARREN AND WHITEHALL WATERSHEDS AREA OF CRITICAL AND ENVIRONMENTAL CONCERN AS DESIGNATED BY THE MASSACHUSETTS DEPARTMENT OF CONSERVATION AND RECREATION.

ALL UNDERGROUND UTILITY DATA REPRESENTS RECORD INFORMATION RECOVERED THROUGH RESEARCH WITHOUT SURFACE DEMARCATION NOR SUBSURFACE VERIFICATION

### TEMPORARY BENCHMARK CHART:

T.B.M.#	DESCRIPTION	ELE VA TION
3	MAGNETIC NAIL SET IN BITUMINOUS ROADWAY	446.12
<u> </u>	MAGNETIC NAIL SET IN BITUMINOUS ROADWAY	446.83

(SEE NOTE 6)

#### UNOFFICIAL SOILS INFORMATION

DATE: JUNE 25, 2018 CONDUCTED BY: ANDREW RODRIGUEZ, SE (13890)

### TEST PIT <u>TP-1</u>

GRA VEL

*ACCESS* 

PATH

 $ELEV.=468X\pm$ ASSUMED E.S.H.G.W. ELEV. = DEEPER THAN 463±

0"-11" AP HORIZON: SANDY LOAM

11"-22" B HORIZON: FINE SANDY LOAM 22"-60"R LAYER C: GRAVELY SANDY LOAM WITH COBBLES AND BOULDERS

#### REDOX NOT OBSERVED WEEPING NOT OBSERVED

#### TEST PIT <u>TP-2</u> $ELEV. = 470 \pm$

ASSUMED E.S.H.G.W. ELEV. = DEEPER THAN 462.5±

0"-7" AP HORIZON: SANDY LOAM 7"-22" B HORIZON: FINE SANDY LOAM

22"-32" LAYER B/C: GRAVELY SANDY LOAM WITH COBBLES AND BOULDERS 32"-90"R LAYER C: GRAVELY SANDY LOAM WITH COBBLES AND BOULDERS

REDOX NOT OBSERVED WEEPING NOT OBSERVED

#### LEGEND:

13. MAP 49/LOT 1B — KNOWLTON FARMS NOMINEE TRUST (43 ESTABROOK AVENUE)

14. MAP 49/LOT 6 - KNOWLTON FARMS NOMINEE TRUST (43 ESTABROOK AVENUE)



- 2. THE SUBJECT PROPERTY DEPICTED IS LOCATED IN ZONE RESIDENTIAL (R40).
- DEPICTED OR NOT DEPICTED. THE CONTRACTOR, PRIOR TO COMMENCEMENT OF CONSTRUCTION, SHALL VERIFY THE LOCATION OF ALL UTILITIES AND CONTACT DIG SAFE AT 1-888-344-7233.
- 5. THIS PLAN DOES NOT SHOW ANY UNRECORDED OR UNWRITTEN EASEMENTS WHICH MAY EXIST. A REASONABLE AND DILIGENT ATTEMPT HAS BEEN MADE TO OBSERVE ANY APPARENT, VISIBLE USES OF THE LAND; HOWEVER, THIS DOES NOT CONSTITUTE A GUARANTEE THAT NO SUCH
- 6. THE ELEVATIONS DEPICTED HEREON ARE BASED UPON NORTH AMERICAN VERTICAL DATUM OF 1988 (NAVD88) AND DERIVED WITH GPS OBSERVATIONS ON APRIL 1, 2013.
- DERIVED FROM GPS OBSERVATIONS ON APRIL 1, 2013.
- 9. THE WETLAND FLAGS DEPICTED WERE DEMARCATED BY LEC ENVIRONMENTAL CONSULTANTS, INC.
- OF GEOSYNTEC CONSULTANTS ON JUNE 25-26, 2014.

#### NOW OR FORMERLY WALDO W. SIMPSON, JR. & BARBARA L. SIMPSON SINGLE FAMILY **DWELLING 4** WF A6 *₩F B33* -WOODEN POLE **₩**F B34 SUPPORT 18"PLASTIC BOX CULVERT INV = 430.53. + WF B36 COLLARSED \ INV=434.0 -UPN19-11.5 WF B39 HEALWALK ESTABROOK AVENUE (PUBLIC VARIABLE WIDTH) INV = 424.98UPN10-NOW OR FORMERLY 1'X1' STONE-PATRICIA K. KNOWLTON, TRS. BOX CULVERT KNOWLTON FARMS NOMINEE TRUST INV = 432.8

GRAPHIC SCALE

SCALE 1"=60'

0 30 60

METERS O

6' CHAINLINK FENCE

LOT 1

TOTAL AREA

 $=2,407,039\pm S.F.$ 

1 DP19-2 4

January January 1

12" RISER PIPE WITH

WITH TWO 6" ORIFICES

ORIFICE INVERT=486.9

HDPE INVERT=485.0

STONE

PIPE OUTLET

10' BUFFER FROM A SA-

POTENTIAL STORMWATER
WETLAND AREA

−1NV=484.0

" DIAMETER GRATE

RIM = 487.9

12" RISER PIPE WITH

12" DIAMETER GRATE

WITH TWO 6" ORIFICES

ORIFICE INVERT=486.8

HDPE INVERT=485.2

rRIM = 487.8

INV=484.0

POTENTIAL STORMWATER

RISER PIPE WHTH "4" ORIFICE R/M = 486.0

INV#482.0

UP19-4 6 X

VINYL PICKET

LOT 1B

TOTAL AREA

 $=872,505\pm S.F.$ 

 $=(20.0\pm AC.)$ 

\ ORIFICE INVERT=485/5 HDPE INVERT=483.5%

# RECORD OWNER:


KNOWLTON FARMS NOMINEE TRUST PATRICIA K. KNOWLTON, TRS. 43 ESTABROOK STREET GRAFTON, MASSACHUSETTS 01519 - DEED BOOK 35401, PAGE 337 \* ASSESSORS MAP 49/LOT 1

### **REFERENCES:**

-PLAN BOOK 177, PLAN 56 \* -PLAN BOOK 203, PLAN 82 \* -PLAN BOOK 291, PLAN 71 \* -PLAN BOOK 783, PLAN 102 \* -PLAN BOOK 784, PLAN 32 \* -PLAN BOOK 786, PLAN 9 \* -PLAN BOOK 786, PLAN 10 \* -PLAN BOOK 852, PLAN 77 \* -PLAN BOOK 903, PLAN 23 \*

\* DENOTES DOCUMENTS RECORDED AT THE WORCESTER DISTRICT REGISTRY

# 43 ESTABROOK AVENUE

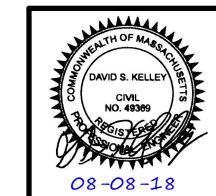

**REVISIONS** 

DSK DSK

DSK DSK

BY CHK'D

PEER REVIEW COMMENTS

POTENTIAL WETLAND

DESCRIPTION

2 | 08/08/18 |

1 07/19/18

DWG. No. 6108-PILOT\_REC | NO. | DATE

CONDITIONS PLAN OF LAND LOCATED IN GRAFTON, MASSACHUSETTS

(WORCESTER COUNTY)

PREPARED FOR ESTABROOK VALLEY, LLC SCALE: 1" = 60'DATE: JUNE 26, 2018




TELEPHONE: (978) 299-0447

BEVERLY, MASSACHUSETTS 01915 WESTBOROUGH, MASSACHUSETTS 01581

SHEET No. 2 OF 5

PROJECT No. 6108

TELEPHONE: (508) 871-7030

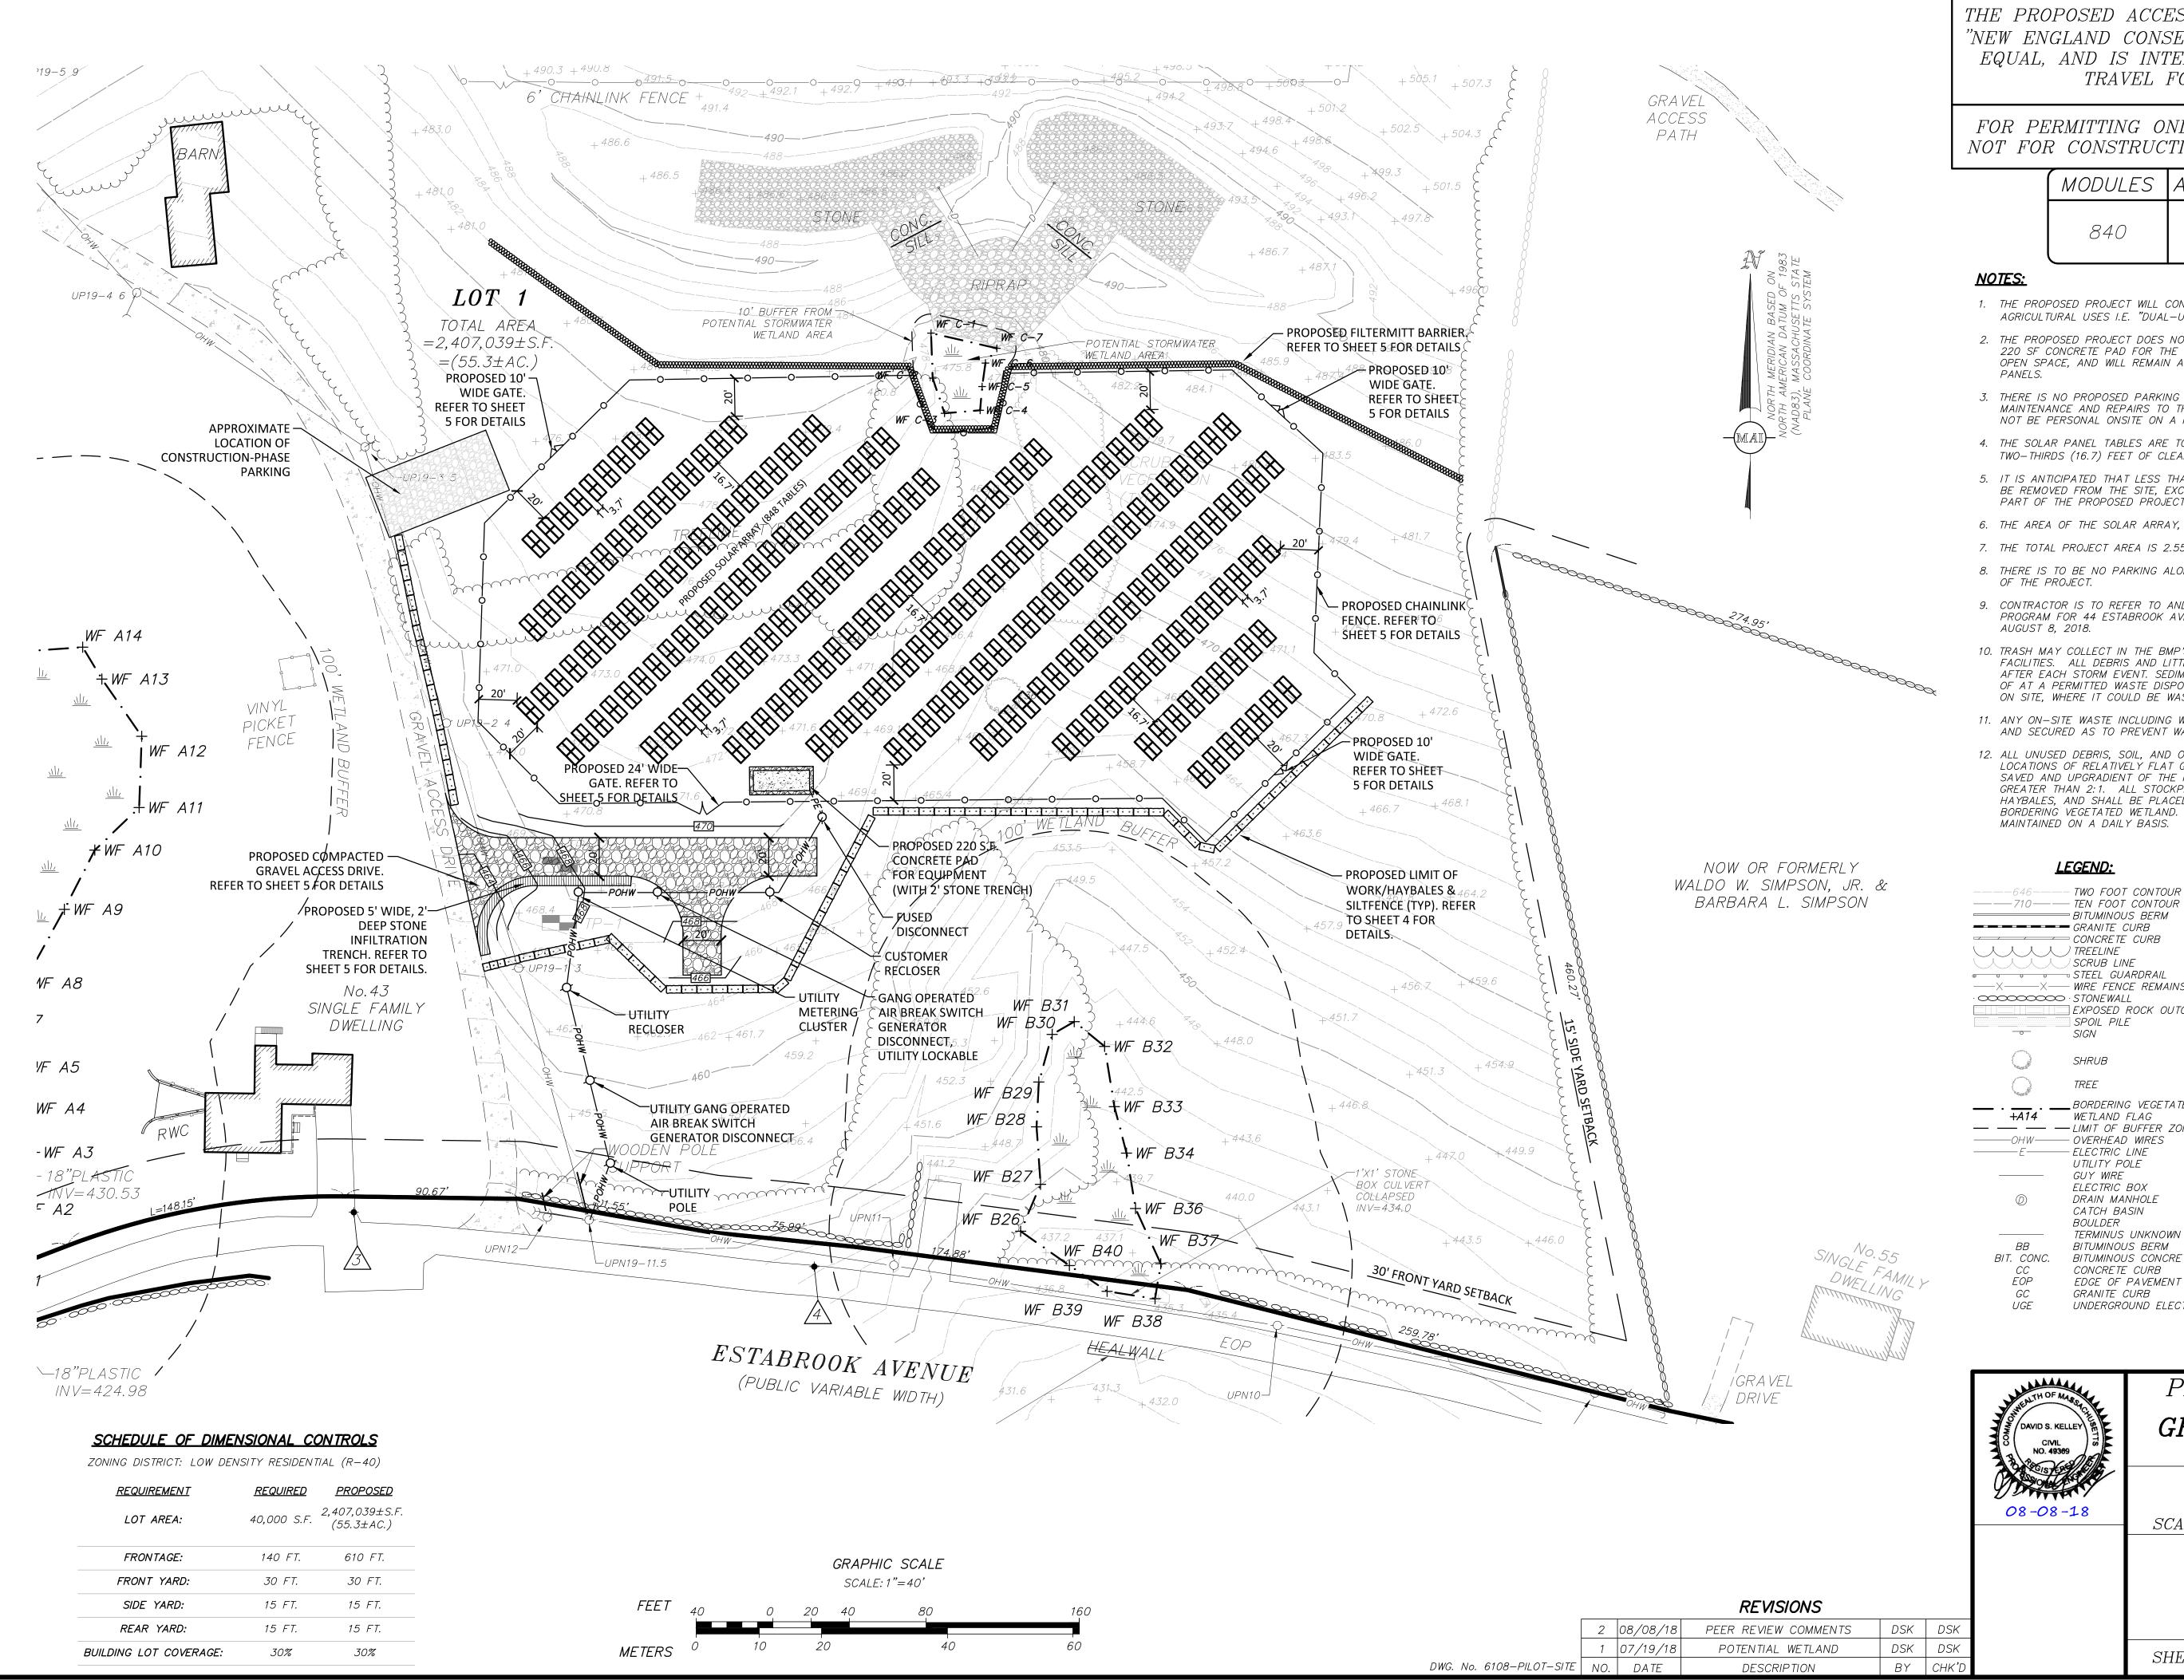

THE PROPOSED ACCESS PATHS SHALL BE VEGETATED USING "NEW ENGLAND CONSERVATION/WILDLIFE MIX", OR APPROVED EQUAL, AND IS INTENDED TO PROVIDE A LEVEL PATH OF TRAVEL FOR MAINTENANCE VEHICLES

FOR PERMITTING ONLY NOT FOR CONSTRUCTION

SEE SHEET 2 OF 5 FOR GENERAL NOTES AND LEGEND

MODULES	AC POWER	DC POWER
840	250±KW	331±KW

#### NOTES:

- 1. THE PROPOSED PROJECT WILL CONSIST OF A GROUND MOUNTED SOLAR FARM WITH AGRICULTURAL USES I.E. "DUAL-USE".
- 2. THE PROPOSED PROJECT DOES NOT INCLUDED IMPERVIOUS AREAS OTHER THAN THE 220 SF CONCRETE PAD FOR THE ELECTRICAL EQUIPMENT. THE SITE IS PRESENTLY OPEN SPACE, AND WILL REMAIN AS OPEN SPACE WITH GROUND MOUNTED SOLAR
- 3. THERE IS NO PROPOSED PARKING AS THE SITE WILL ONLY BE ACCESSED FOR MAINTENANCE AND REPAIRS TO THE SOLAR PANELS AND EQUIPMENT. THERE WILL NOT BE PERSONAL ONSITE ON A REGULAR BASIS.
- 4. THE SOLAR PANEL TABLES ARE TO BE LAID OUT AS TO PROVIDE SIXTEEN AND TWO-THIRDS (16.7) FEET OF CLEAR SPACE BETWEEN EACH ROW.
- 5. IT IS ANTICIPATED THAT LESS THAN 1,000 CUBIC YARDS OF MATERIAL WILL NEED TO BE REMOVED FROM THE SITE, EXCLUDING VEGETATION NEEDED TO BE REMOVED AS A PART OF THE PROPOSED PROJECT.
- 6. THE AREA OF THE SOLAR ARRAY, WITHIN THE FENCE, IS 2.05± ACRES.
- 7. THE TOTAL PROJECT AREA IS 2.55± ACRES.
- 8. THERE IS TO BE NO PARKING ALONG ESTABROOK AVENUE DURING THE CONSTRUCTION OF THE PROJECT.
- 9. CONTRACTOR IS TO REFER TO AND COMPLY WITH THE OPERATION AND MAINTENANCE PROGRAM FOR 44 ESTABROOK AVENUE, PREPARED BY MERIDIAN ASSOCIATES DATED AUGUST 8, 2018.
- 10. TRASH MAY COLLECT IN THE BMP'S, POTENTIALLY CAUSING CLOGGING OF THE FACILITIES. ALL DEBRIS AND LITTER SHALL BE REMOVED WHEN NECESSARY, AND AFTER EACH STORM EVENT. SEDIMENT AND DEBRIS COLLECTED SHOULD BE DISPOSED OF AT A PERMITTED WASTE DISPOSAL FACILITY. AVOID DISPOSING OF THIS MATERIAL ON SITE, WHERE IT COULD BE WASHED INTO THE PROPOSED SWALES AND BASINS.
- 11. ANY ON-SITE WASTE INCLUDING WASTE PACKAGING AND IS TO BE PROPERLY STORED AND SECURED AS TO PREVENT WASTE FROM BEING BLOWN AROUND BY THE WIND.
- 12. ALL UNUSED DEBRIS, SOIL, AND OTHER MATERIAL SHALL BE STOCKPILED IN LOCATIONS OF RELATIVELY FLAT GRADES, AWAY FROM ANY TREES IDENTIFIED TO BE SAVED AND UPGRADIENT OF THE HAYBALES. STOCKPILE SIDE SLOPES SHALL NOT BE GREATER THAN 2:1. ALL STOCKPILES SHALL BE SURROUNDED BY A ROW OF HAYBALES, AND SHALL BE PLACED OUTSIDE THE 100 FOOT BUFFER TO ANY BORDERING VEGETATED WETLAND. SURROUNDING HAYBALES SHALL BE INSPECTED AND MAINTAINED ON A DAILY BASIS.



# 43 ESTABROOK AVENUE

PROPOSED UTILITY POLE



GC

GRANITE CURB

UNDERGROUND ELECTRIC

SITE PLAN OF LAND LOCATED IN GRAFTON, MASSACHUSETTS

(WORCESTER COUNTY)

PREPARED FOR ESTABROOK VALLEY, LLC

DATE: JUNE 26, 2018 SCALE: 1" = 40'

SHEET No. 3 OF 5



BEVERLY, MASSACHUSETTS 01915 WESTBOROUGH, MASSACHUSETTS 0158 TELEPHONE: (978) 299-0447 TELEP WWW.MERIDIANASSOC.COM TELEPHONE: (508) 871-7030

PROJECT No. 6108

- 1. EXISTING GROUND WITHIN THE PROPOSED CHAINLINK FENCE SHALL BE CLEARED, STUMPED AND RE-GRADED TO ELIMINATE MINOR SURFACE DISTURBANCES. RE-VEGETATION OF THE SITE SHALL BE ESTABLISHED WITH LOW GROWTH GROUND COVER.
- 2. THE PROPOSED LIMIT OF WORK LINE ALSO DEPICTS THE EXTENT OF TREE CLEARING TO BE PERFORMED ON THE PROJECT SITE. NO TREES OUTSIDE THE DESIGNATED LIMIT OF WORK LINE ARE TO BE REMOVED BY THE CONTRACTOR.
- COMMON FILL (SITE GRADING AREAS) SHALL CONSIST OF MINERAL SOIL SUBSTANTIALLY FREE FROM ORGANIC MATERIALS, LOAM, WOOD TRASH AND OTHER OBJECTIONABLE MATERIALS WHICH MAY BE COMPRESSIBLE OR WHICH CANNOT BE PROPERLY COMPACTED. SELECT COMMON FILL SHALL NOT CONTAIN STONES LARGER THAN 2-IN. IN LARGEST DIAMETER AND SHALL HAVE A MAXIMUM OF 75% PASSING THE NO. 40 SIEVE AND A MAXIMUM OF 20% PASSING THE NO. 200 SIEVE. SELECT COMMON FILL SHALL NOT CONTAIN GRANITE BLOCKS, BROKEN CONCRETE, MASONRY RUBBLE OR OTHER SIMILAR MATERIALS. IT SHALL HAVE PHYSICAL PROPERTIES SUCH THAT IT CAN BE READILY SPREAD AND COMPACTED DURING FILLING. SNOW, ICE AND FROZEN SOIL WILL NOT BE PERMITTED. SOIL EXCAVATED FROM THE STRUCTURE AREAS AND WHICH MEETS THE ABOVE REQUIREMENTS MAY BE USED.
- ORDINARY FILL SHALL BE WELL GRADED, NATURAL INORGANIC SOIL, FREE OF ORGANIC OR OTHER WEAK OR COMPRESSIBLE MATERIALS, FROZEN MATERIALS, AND OF STONES LARGER THAN TWO THIRDS (3/3) THE LIFT THICKNESS. IT SHALL BE OF SUCH NATURE AND CHARACTER THAT IT CAN BE COMPACTED TO THE SPECIFIED DENSITIES IN A REASONABLE LENGTH OF TIME. IT SHALL BE FREE OF PLASTIC CLAY, OF ALL MATERIALS SUBJECT TO DECAY, DECOMPOSITION, OR DISSOLUTION, AND OF CINDERS OR OTHER MATERIALS THAT WILL CORRODE PIPING OR OTHER METAL. IT SHALL HAVE A MINIMUM DRY DENSITY OF NOT LESS THAN 120 POUNDS PER CUBIC FOOT. MATERIAL FROM EXCAVATION ON THE SITE MAY BE USED AS ORDINARY FILL IF IT MEETS THE ABOVE REQUIREMENTS. ORDINARY FILL SHALL HAVE A MAXIMUM OF 60% PASSING THE #40 SIEVE, AND A MAXIMUM OF 20% PASSING THE #200 SIEVE. IT SHOULD NOT CONTAIN BROKEN CONCRETE, MASONRY RUBBLE OR OTHER SIMILAR MATERIALS. AND SHALL HAVE PHYSICAL PROPERTIES SUCH THAT IT CAN BE READILY SPREAD AND COMPACTED DURING FILLING. SNOW, ICE AND FROZEN SOIL SHALL NOT BE PERMITTED.
- SELECT COMMON FILL (ROADWAY AREAS) SHALL BE PLACED IN LAYERS HAVING A MAXIMUM THICKNESS OF 8 IN. MEASURED BEFORE COMPACTION. EACH LAYER OF FILL SHALL BE COMPACTED TO AT LEAST 95 PERCENT OF MAXIMUM DRY DENSITY DETERMINED BY THE ASTM D1557. COMPACTION OF STRUCTURAL FILL SHALL CONSIST OF FULLY LOADED TEN WHEEL TRUCKS, A TRACTOR DOZER WEIGHING AT LEAST 30,000 LBS AND OPERATED AT FULL SPEED. A HEAVY VIBRATORY ROLLER. OR OTHER METHOD ONLY AS APPROVED BY THE ENGINEER. COMPACTION OF SELECT COMMON FILL IN CONFINED AREAS ADJACENT TO STRUCTURES SHALL BE ACCOMPLISHED BY HAND OPERATED VIBRATORY EQUIPMENT OR MECHANICAL TAMPERS APPROVED BY THE ENGINEER. AS A MINIMUM, COMPACTION OF SELECT COMMON FILL SHALL CONSIST OF FOUR COVERAGES OF THE APPROVED EQUIPMENT.
- 6. SITE PREPARATION SHALL INCLUDE CLEARING, GRUBBING, DELETERIOUS SOILS, VEGETATION AND DEBRIS. ALL TREES, STUMPS, BRUSH, SHRUBS, ROOTS, GRASS, WEEDS, RUBBISH, STONES LARGER THAN 2-IN. IN THE LARGEST DIAMETER AND OTHER OBJECTIONABLE MATERIAL SHALL BE REMOVED AND DISPOSED OF FROM AREAS TO BE FILLED AND COMPACTED. AREAS OUTSIDE OF THE LIMITS OF WORK SHALL BE PROTECTED FROM DAMAGE AND NO EQUIPMENT OR MATERIALS SHALL BE STORED IN THESE AREAS. NO STUMPS, TREES, LIMBS, OR BRUSH SHALL BE BURIED IN ANY FILLS OR EMBANKMENTS.
- EROSION AND SEDIMENT CONTROL, BOTH DURING AND AFTER CONSTRUCTION, SHALL BE PROVIDED AS REQUIRED TO RETAIN SEDIMENT ONSITE, AND TO CONTROL EROSION OF EMBANKMENTS, TEMPORARY AND FINAL EXPOSED SLOPES, AND TEMPORARY MATERIAL STOCKPILE(S). SILT FENCES, CHECK DAMS, DRAINAGE DITCHES OR SWALES, TEMPORARY SEEDING, AND PRE-MANUFACTURED TEXTILES, GEOTUBES, GEOGRID, CELLULAR GEOWEB, ETC., SHALL BE UTILIZED AS APPROPRIATE. EROSION AND SETTLEMENT CONTROL MEASURES SHALL BE IN ACCORDANCE WITH ALL PERMITS AND CODES AND THIS SPECIFICATION. DURING THE EXCAVATION OF THE WORK AT THE SITE, OPERATIONS SHALL BE CONTINUOUSLY MONITORED TO AVOID THE CREATION OF CONDITIONS THAT COULD LEAD TO EXCESSIVE EROSION OF SOIL WITH SURFACE RUNOFF FROM THE WORK AREAS. CONTROLS SHALL BE PROVIDED TO PROTECT THE WATER QUALITY AND SHALL BE IN ACCORDANCE WITH PROJECT DOCUMENTS AND ALL LOCAL, STATE AND FEDERAL LAWS AND REGULATIONS. EROSION CONTROL MEASURES SHALL BE EMPLOYED TO REDUCE EROSION OF SLOPES AND SILTATION OF OFF-SITE OUTFALLS AND TRIBUTARIES.
- 8. UPON SIGNS OF CONCENTRATED FLOW BY EVIDENCE OF GULLYING OR RILLING IN DISTURBED AREAS, HAYBALES SHALL BE PLACED IN THESE AREAS, SPACED EVERY 50' IN THE UPGRADIENT SLOPE.
- 9. ALL DISTURBED AREAS SHALL BE RE-ESTABLISHED WITH "NEW ENGLAND CONSERVATION/WILDLIFE MIX" OR APPROVED EQUAL.

### ESTABLISHED GUIDELINES FOR NEW <u>ENGLAND CONSERVATION/WILDLIFE MIX</u>

THE MIX PROVIDES A PERMANENT COVER OF GRASSES, WILDFLOWERS AND LEGUMES TO PROVIDE BOTH GOOD EROSION CONTROL AND WILDLIFE HABITAT VALUE. THIS MIX IS DESIGNED TO BE A NO MAINTENANCE SEEDING, AND IT IS APPROPRIATE TO CUT AND FILL SLOPES, DETENTION BASIN SLOPES, AND DISTURBED AREAS ADJACENT TO COMMERCIAL AND RÉSIDENTIAL PROJECTS. ALWAYS APPLY ON CLEAN BARE SOIL. THE MIX MAY BE APPLIED BY HYDRO-SEEDING, BY MECHANICAL SPREADER, OR ON SMALL SITES IT CAN BE SPREAD BY HAND. LIGHTLY RAKE, OR ROLL TO ENSURE PROPER SEED TO SOIL CONTACT. BEST RESULTS ARE OBTAINED WITH A SPRING SEEDING. LATE SPRING THROUGH EARLY SUMMER SEEDING WILL BENEFIT WITH A LIGHT MULCHING OF WEED-FREE STRAW TO CONSERVE MOISTURE. IF CONDITIONS ARE DRIER THAN USUAL. WATERING WILL BE REQUIRED. LATE FALL AND WINTER DORMANT SEEDING REQUIRE AN INCREASE IN THE SEEDING RATE. FERTILIZATION IS NOT REQUIRED UNLESS THE SOILS ARE PARTICULARLY INFERTILE. PREPARATION OF A CLEAN WEED FREE SOIL SURFACE IS NECESSARY FOR OPTIMAL RESULTS.

- ELYMUS VIRGINICUS
- SCHIZACHYRIUM SCOPARIUM FESTUCA RUBRA
- ANDROPOGON GERARDII
- CHAMAECRISTA FASCICULATA PANICUM CLANDESTINUM
- PANICUM VIRGATUM
- SORGHASTRUM NUTANS HELENIUM AUTUMNALE HELIOPSIS HELIANTHOIDES
- VERBENA HASTATA ASCLEPIAS SYRIACA
- ASTER UMBELLATUS EUPATORIUM PURPUREUM
- SOLIDAGO JUNCEA ZIZIA AUREA

# SEED BED PREPARATION:

REMOVE ALL INVASIVE SPECIES, TILL EXISTING SOIL AND RAKE SMOOTH. APPLY 3" OF COMPOSTED LEAF LITTER. ALL AREAS WHERE ROOTS HAVE BEEN GRUBBED SHALL BE

### SEED APPLICATION AND RATE:

THE IDEAL PLANTING DEPTH IS 1/4-1/2". UNDER IDEAL CONDITIONS SEEDS LAYING ON THE SURFACE WILL GERMINATE. RECOMMENDED APPLICATION RATE FOR SEEDING IS 1 LBS PER 1,750 SQUARE FEET.

FOR FALL INSTALLATION, SEED BETWEEN AUGUST 15 AND SEPTEMBER 10. FOR SPRING INSTALLATION, SEED AS EARLY AS POSSIBLE SOMETIME BETWEEN APRIL 15 AND MAY 10.


FERTILIZATION AND SOIL REQUIREMENTS: REFER TO MANUFACTURERS RECOMMENDATIONS

REFER TO MANUFACTURERS RECOMMENDATIONS

GENERAL MAINTENANCE:


REFER TO MANUFACTURERS RECOMMENDATIONS


FOR PERMITTING ONLY NOT FOR CONSTRUCTION

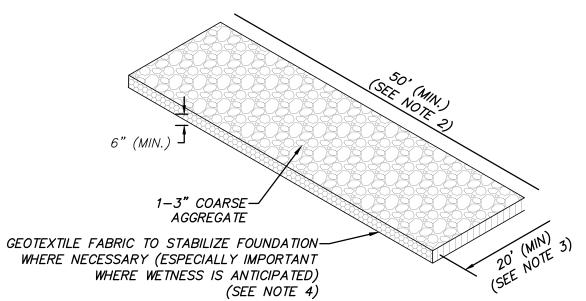


- 1. THE SOLE PURPOSE OF THIS DETAIL IS TO PROVIDE A STABLE ENTRANCE AND EXIT FROM A CONSTRUCTION SITE OR WETLAND CROSSING AND KEEP MUD AND SEDIMENT OFF PUBLIC ROADS AND WETLANDS IN ACCORDANCE WITH THE RECOMMENDATIONS STATED IN THE "MASSACHUSETTS EROSION AND SEDIMENT CONTROL GUIDELINES FOR URBAN AND SUBURBAN AREAS" AS PREPARED BY THE MASSACHUSETTS DEPARTMENT OF ENVIRONMENTAL PROTECTION.
- 2. EXTEND PAD BEYOND 50 FEET FOR HEAVY CONSTRUCTION TRAFFIC AS NECESSARY. LONGER ENTRANCES WILL PROVIDE BETTER CLEANING ACTION.
- 3. THE PAD SHALL EXTEND THE FULL WIDTH OF THE CONSTRUCTION ACCESS DRIVE.
- 4. WHERE NECESSARY, GEOTEXTILE FILTER FABRIC SHALL BE PLACED BETWEEN THE STONE FILL AND THE EARTH SURFACE BELOW THE PAD TO REDUCE THE MIGRATION OF SOIL PARTICLES FOR UNDERLYING SOIL INTO THE STONE AND VICE VERSA.


#### TEMPORARY GRAVEL CONSTRUCTION TRACKING PAD

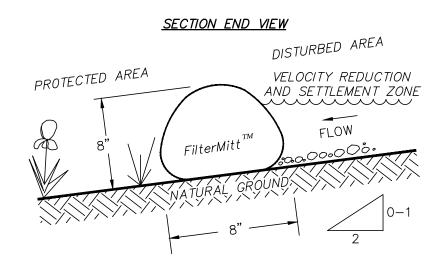

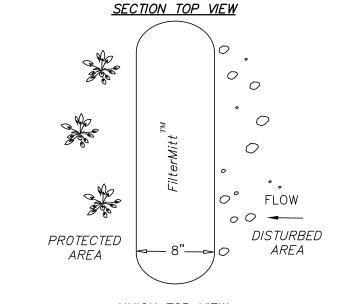

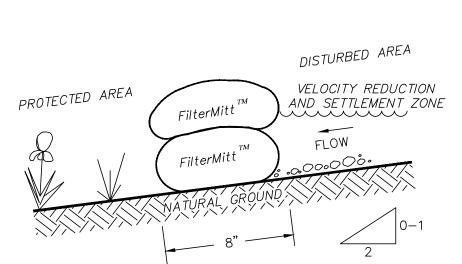

UNION END VIEW

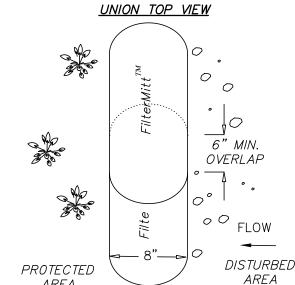

# FilterMitt \*\*\* COMPONENTS

100% organic hessian. OUTSIDE CASING: FiberRoot Mulch TM FILLER INGREDIENT: • A BLEND OF COARSE AND FINE COMPOST AND SHREDDED

• PARTICLE SIZES: 100% PASSING A 3" SCREEN; 90-100% PASSING A 1" SCREEN; 70-100% PASSING A 0.75" SCREEN; 30-75% PASSING

A 0.25" SCREEN. • WEIGHT: APPROX. 310 LBS./CU.YD.

(AVE. 11.5 LBS./L.F.)

For more information visit: <u>www.groundscapesexpress.com</u>or contact us at:

# Groundscapes Express, Inc.

P.O. Box 737 Wrentham, MA 02093 (508) 384-7140

# FilterMitt \*\*\* INSTALLATION:

8" WIDE.

WITH THE NEWEST TECHNOLOGY AND EQUIPMENT, SECTIONS CAN BE CONSTRUCTED ON SITE IN LENGTHS FROM 1' TO 100'.


SECTIONS CAN ALSO BE DELIVERED TO THE SITE IN LENGTHS FROM 1' TO 8'.


THE FLEXIBILITY OF FilterMitt TM ALLOWS IT TO CONFORM TO ANY CONTOUR OR TERRAIN WHILE HOLDING A SLIGHTLY ROUND SHAPE AT 8" HIGH BY

WHERE SECTION ENDS MEET, THERE SHALL BE AN OVERLAP OF 6" OR GREATER.

# FILTERMITT 2:1 SLOPES OR LESS

(NOT TO SCALE)

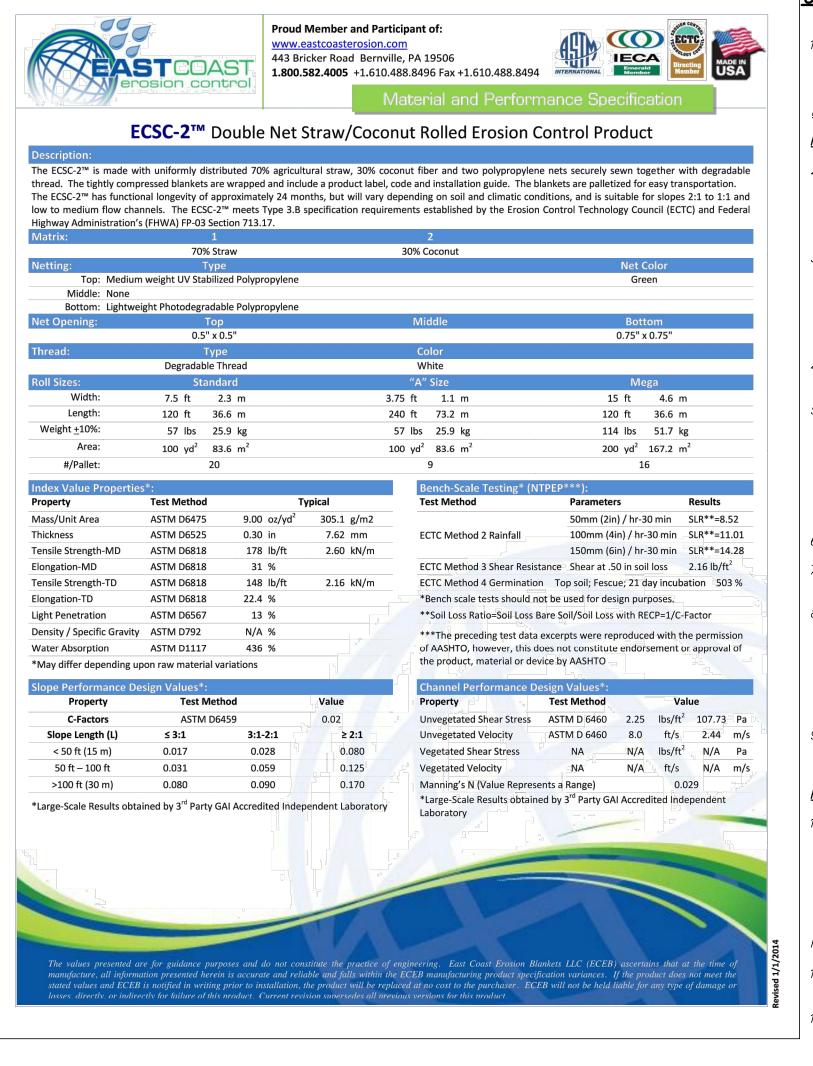

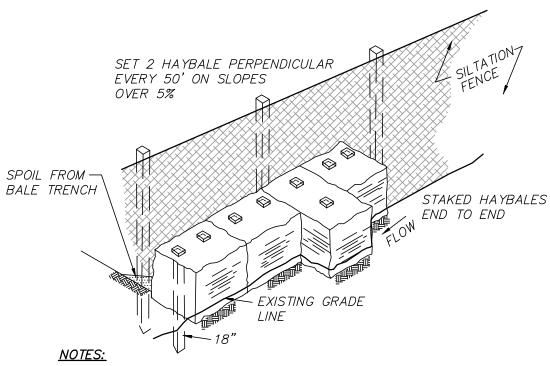

- 1. BALES TO BE TIED WITH ORGANIC FIBER TWINE ONLY NO PLASTIC OR WIRE.
- 2. HAYBALES TO BE SECURED WITH A MINIMUM OF TWO (2) 1" x 1" WOODEN STAKES PER BALE DRIVEN 18" MIN. INTO

# HAYBALE WITH SILT FENCE BARRIER

(NOT TO SCALE)

### GENERAL SEQUENCE OF CONSTRUCTION:

CONTACT DIGSAFE (888.344.7233) AND OBTAIN CLEARANCE AT LEAST 72 HOURS BEFORE INITIATING ANY ÉXCAVATION.

<u>SITE PREPARATION SHALL BE CONDUCTED IN TWO (2) PHASES</u> IN ORDER TO MAXIMIZE EROSION AND SEDIMENTATION CONTROL

- ESTABLISH PHASE 1 EROSION AND SEDIMENTATION CONTROL MEASURES (HAYBALES & SILT FENCE) AS DEPICTED HEREIN AND AROUND AREAS OF DISTURBANCE AND MAINTAIN THROUGHOUT CONSTRUCTION IN ACCORDANCE WITH LOCAL REQUIREMENTS. PERFORM INSPECTIONS, REPAIR IF NECESSARY, AND DOCUMENT AFTER EACH PRECIPITATION EVENT OF 0.25-INCHES OR GREATER.
- PRIOR TO CONSTRUCTION, THE CONTRACTOR SHALL CONSTRUCT THE TEMPORARY GRAVEL CONSTRUCTION ENTRANCE/EXIT PAD AT BOSTON POST ROAD. THE PAD SHALL CONSIST OF 1"-3" COARSE AGGREGATE WITH MINIMUM DIMENSIONS OF 50' (LENGTH) x 20' (WIDTH) x 6" (DEPTH) AND SET ON GEOTEXTILE FABRIC TO STABILIZE FOUNDATION (ESPECIALLY IMPORTANT WHERE WETNESS IS ANTICIPATED).
- PERFORM LIMITED CLEARING ACTIVITIES IN ORDER TO CONSTRUCT GRAVEL ACCESS DRIVE AND TURNAROUND.
- SITE PREPARATION SHALL INCLUDE CLEARING AND REMOVAL OF EXISTING VEGETATION AND DEBRIS. ALL TREES, STUMPS, BRUSH, SHRUBS, ROOTS, GRASS, WEEDS, RUBBISH, BITUMINOUS PAVEMENT, STONES LARGER THAN 2-IN. IN THE LARGEST DIAMETER AND OTHER OBJECTIONABLE MATERIAL SHALL BE REMOVED AND DISPOSED OF FROM AREAS TO BE FILLED AND COMPACTED. AREAS OUTSIDE OF THE LIMITS OF WORK SHALL BE PROTECTED FROM DAMAGE. NO STUMPS, TREES, LIMBS, OR BRUSH SHALL BE BURIED IN ANY FILLS OR EMBANKMENTS.
- 6. CONSTRUCT SEDIMENTATION BASINS (SHOWN ON PLANS).
- GRUBBING OF AREAS WITHIN THE PROPOSED FENCE AND GRADING AREAS ONLY SHALL BE CONDUCTED AFTER THE INSTALLATION OF THE SEDIMENTATION BASIN.
- 8. FOR AREAS WHERE NO GRADING IS PROPOSED, REPAIR UNEVEN AREAS WITHIN LIMITS OF THE SOLAR DEVELOPMENT. AS NECESSARY TO CREATE A TOLERABLE GROUND SURFACE. GENERAL TOLERANCE FOR ALLOWABLE GROUND SLOPE IS TWO FOOT VERTICAL CHANGE OVER A 20 FOOT HORIZONTAL RUN NOTE THAT THIS REFERS TO THE ALLOWABLE LONGITUDINAL SLOPE (I.E., ALONG THE CONTOUR) AND NOT THE INCLINATION OF THE EXPOSURE (I.E., PERPENDICULAR TO THE CONTOUR)].
- UPON SIGNS OF CONCENTRATED FLOW BY EVIDENCE OF GULLYING OR RILLING IN DISTURBED AREAS, HAYBALES, OR APPROVED EQUAL, SHALL BE PLACED IN THESE AREAS, SPACED EVERY 50' IN THE UPGRADIENT SLOPE.

#### PHASE II:


10. ESTABLISH PHASE II EROSION AND SEDIMENTATION CONTROL MEASURES (HAYBALES & SILT FENCE) AS DEPICTED HEREIN AND AROUND AREAS OF DISTURBANCE AND MAINTAIN THROUGHOUT CONSTRUCTION IN ACCORDANCE WITH LOCAL REQUIREMENTS. PERFORM INSPECTIONS, REPAIR IF NECESSARY, AND DOCUMENT AFTER EACH PRECIPITATION EVENT OF 0.25-INCHES OR GREATER (PHASE I EROSION CONTROL IS TO REMAIN IN PLACE AND MAINTAINED AS DESCRIBED ABOVE).

REPEAT STEPS 5, 6, 7, 8 AND 9 ABOVE FOR PHASE II.

APPROVED BY THE PROJECT SITE ENGINEER.

- 11. RECEIVE AND STAGE MATERIALS. RE-LOCATE COMPONENTS (E.G., CONDUIT. WIRING AND POSTS) TO SOLAR DEVELOPMENT AREA AS THEY ARE REQUIRED.
- 12. INSTALL RACKING SYSTEM. MOUNT THE PV PANELS ON FRAME AT THE SPECIFIED ORIENTATION AND EXPOSURE (TO BE PROVIDED BY PROJECT MEP PRIOR TO CONSTRUCTION).
- 13. RUN UNDERGROUND ELECTRICAL CONDUIT TO PV FRAMES AND INSTALL PANEL WIRING. (LOCATION TO BE PROVIDED BY PROJECT MEP PRIOR TO CONSTRUCTION)
- 14. INSTALL PV COMBINER BOXES WITH FLEXIBLE CONNECTIONS TO CONNECT PV PANELS TO CONDUIT. (LOCATION TO BE PROVIDED BY PROJECT MEP PRIOR TO CONSTRUCTION)
- 15. CONSTRUCT CONCRETE EQUIPMENT PADS. INSTALL AND CONNECT GROUND MOUNTED ELECTRICAL EQUIPMENT. A DISCONNECT LOCATION WILL BE ON THE OUTSIDE ON THE NARROWEST SIDE OF THE PLATFORM.
- 16. RUN CONDUIT FROM THE CONCRETE EQUIPMENT PADS TOWARDS THE POINT OF INTERCONNECTION AS DEPICTED ON THE SITE PLAN.
- 17. INSTALL RISER POLES AND UTILITY POLES WITH ELECTRICAL COMPONENTS AND OVERHEAD WIRING FROM THE POINT OF INTERCONNECTION TO THE ARRAY.
- 18. CONSTRUCT ALL 7' HIGH CHAIN LINK FENCE AND GATES. (SHOWN ON PLAN)
- 19. ALL DISTURBED AREAS SHALL BE RE-ESTABLISHED WITH "NEW ENGLAND CONSERVATION/WILDLIFE MIX" (DEPICTED HEREIN). IN THE EVENT THAT THE SEEDING FALLS OUTSIDE OF THE RECOMMENDED SEEDING DATES, DISTURBED AREAS SHALL BE RE-ESTABLISHED USING ALTERNATIVES METHODS AS
- 20. REMOVE ANY ACCUMULATED SEDIMENT FROM THE SEDIMENTATION BASINS. THE SEDIMENTATION BASINS ARE TO BE LINED WITH RIPRAP AND REMAIN IN PLACE AFTER CONSTRUCTION.
- 21. RE-PAVE THE BITUMINOUS CONCRETE AT THEN ENTRANCE TO THE SITE. (SHOWN ON PLANS)
- 22. UPON COMPLETION OF CONSTRUCTION ACTIVITIES WITHIN THE LIMIT OF WORK, THE CONTRACTOR SHALL EFFECTIVELY AND PERMANENTLY STABILIZE THE SITE.

# 43 ESTABROOK AVENUE

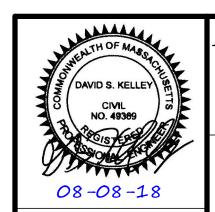

LOCATED IN GRAFTON, MASSACHUSETTS (WORCESTER COUNTY)

> PREPARED FOR ESTABROOK VALLEY, LLC

SCALE: AS NOTED DATE: JUNE 26, 2018



500 CUMMINGS CENTER, SUITE 5950 TELEPHONE: (978) 299-0447


BEVERLY, MASSACHUSETTS 01915 WESTBOROUGH, MASSACHUSETTS 01581 TELEPHONE: (508) 871-7030

SHEET No. 4 OF 5

PROJECT No. 6108

REVISIONS

1 07/19/18 POTENTIAL WETLAND DSK DSK DWG. No. 6108\_PILOT-DET | NO. | DATE DESCRIPTION BY CHK'C

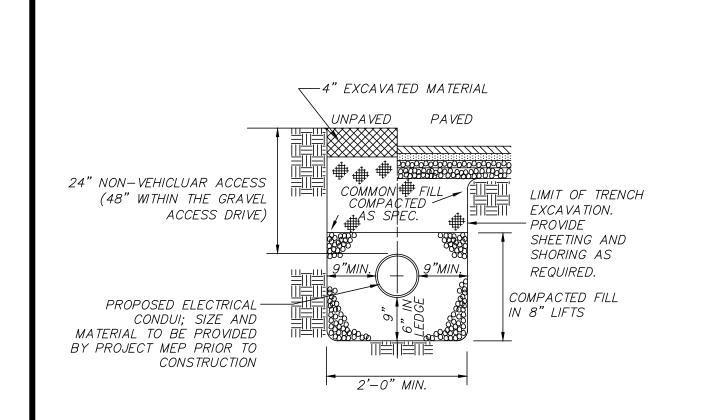

#### FILL SPECIFICATION

No. 100

No. 200 (FINES)

FINE AGGREGATE SHALL CONSIST OF HARD, DURABLE SAND. FRE OF CLAY. ORGANIC MATTER. SURFACE COATINGS, AND OTHER DELETERIOUS MATERIALS. SOIL FINER THAN THE No. 200 SIEVE (THE FINES) SHALL BE NONPLASTIC. FINE AGGREGATÈ FILL SHALL CONFORM TO THE REQUIREMENTS OF THE 1988 MASS. HIGHWAY DEPT. STANDARD SPECIFICATIONS FOR HIGHWAYS AND BRIDGES, SECTION M4.02.02A (2010 SUPPLEMENTAL SPECIFICATIONS). FINE AGGREGATE SHALL MEET THE FOLLOWING GRADATION REQUIREMENTS:


SIEVE SIZE PERCENT PASSING BY WEIGHT 3/8 INCH 100 95 - 100 45 – 80 10 - 30 No. 50


2 - 10

0 – 3

FINE AGGREGATE FILL SHALL BE COMPACTED IN MAXIMUM 9-INCH-THICK LOOSE LIFTS TO AT LEAST 95 PERCENT OF THE MAXIMUM DRY DENSITY DETERMINED IN ACCORDANCE WITH ASTM D1557 (MODIFIED AASHTO COMPACTION)

#### TYPICAL CONDUIT TRENCH DETAIL (NOT TO SCALE)

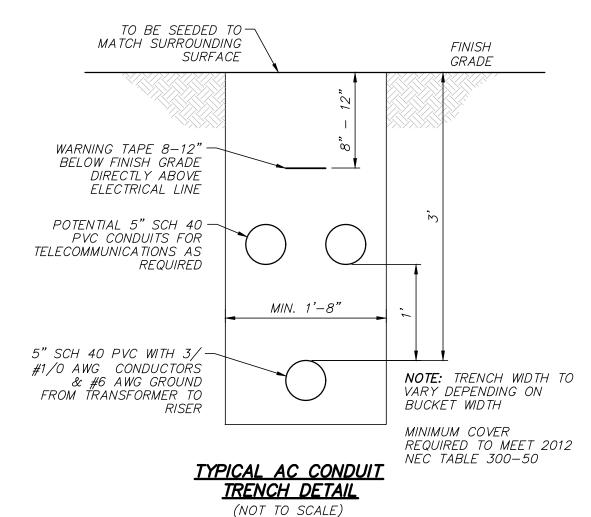

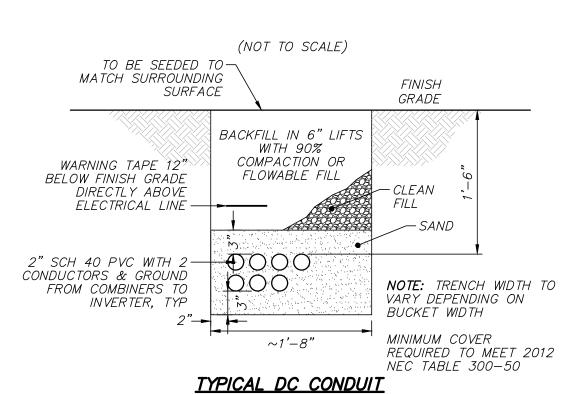


TRENCH DETAIL

(NOT TO SCALE)

(WORK AREA) PLAN VIEW - WOOD STAKES 7' O.C. CHICKEN WIRE MESH FENCING -6"x6" TRENCH WITH BACKFILL IN PLACE CROSS SECTION <u>WRE MESH FENCE DETAIL</u>


- CHICKEN WIRE MESH FENCING

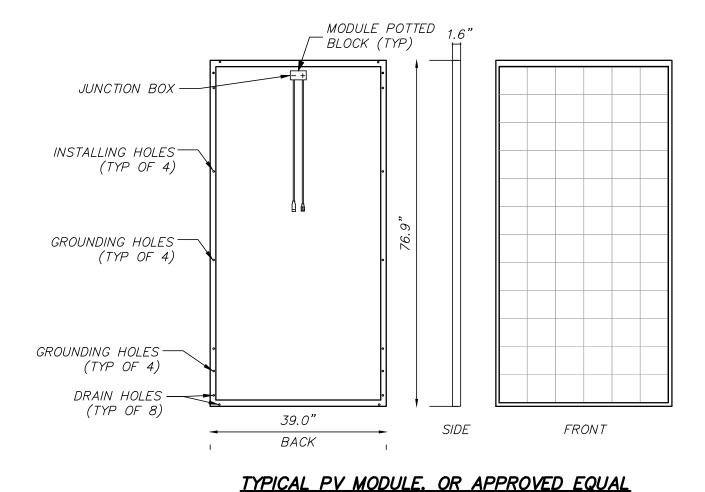

(NOT TO SCALE)


### (SEE SITE PLAN) (MIN) \_\_\_\_ REMOVE ALL TOPSOIL, SUBSOIL, AND OTHER UNSUITABLE MATERIAL APPROVED -UNDER THE PROPOSED ACCESS. STABILIZATION SUBBASE GEOTEXTILE 12" COMPACTED GRAVEL -BORROW SUBGRADE COMPACTED IN 6" LIFTS TYPICAL GRAVEL ACCESS DRIVE


# CROSS SECTION (NOT TO SCALE)

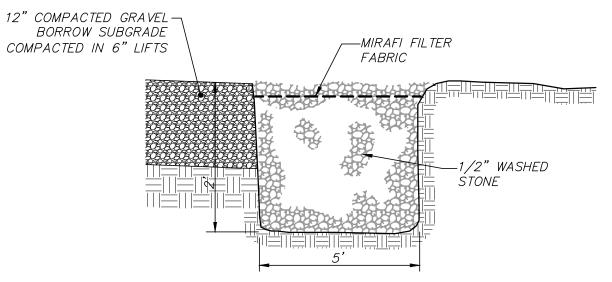

GRAVEL STONE TRENCH DETAIL

(NOT TO SCALE)

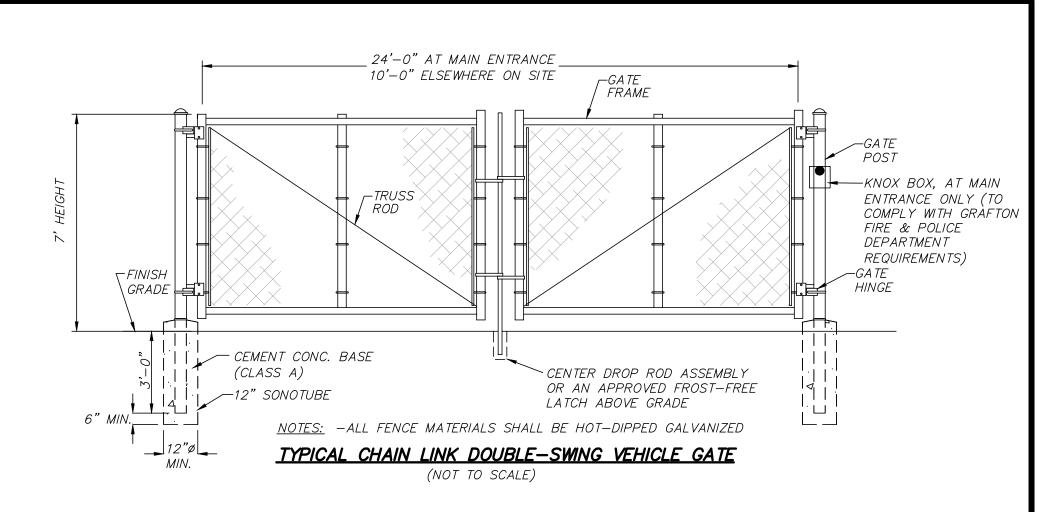

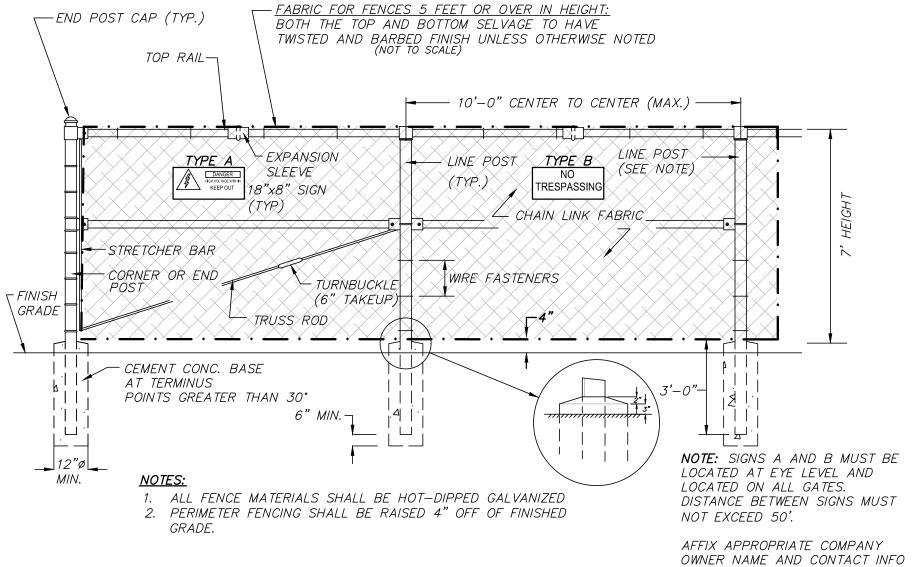

TYPICAL CHAIN LINK FENCE W/ TOPRAIL DETAIL OR APPROVED EQUAL (NOT TO SCALE)

#### -ONLY ONE CONDUCTOR SHOWN FOR - DRIP LOOP BUNDLED TOGETHER CLARITY. DRIP LOOP MAY REQUIRE WITH SUNBUNDLER TIES SUPPORT FOR APPLICATIONS HAVING PV WIRE SUPPORTED ALONG -SMALL WIRE BUNDLES. BUNDLES RACKING STRUCTURE PV SOURCE-CIRCUIT CONDUCTORS -SEALED PVC U-FITTING OR SHALL BE PROTECTED FROM <del>\* - -</del> -BUNDLED INTO A DRIP LOOP WEATHER HEAD CHAFING ON SHARP EDGES GROUND MOUNT RACKING -FLANGE CLIP (TYPICAL) -- PVC COUPLING PV PANEL - SCHEDULE 40 PVC STRAPPED TO POST OR BACKBOARD (TYPICAL) INVERTERS (TYP.) — HOT-DIPPED GALVANIZED STRUT & STRAP (TYPICAL) — #6 CU GROUND SECURE TO POST AND SUPPORT LFNC CONNECTOR - LFNC CONNECTOR GROUND LEVEL GROUND I FVFI NOTE: FINAL POST DEPTH TO BE DETERMINED SUPPORT POST $-\frac{3}{4}$ " DIA X 10'-0" LONG COPPERCLAD GROUND ROD (TYP) TYPICAL RACK SECTION. OR APPROVED EQUAL (NOT TO SCALE)

PLANTING MAINTENANCE NOTES: LANDSCAPING SHALL BE PROPERLY

MAINTAINED, ANY DEAD OR DISEASED PLANTINGS SHALL BE REPLACED IN THE NEXT IMMEDIATE SPRING OR FALL PLANTING SEASON.

08-08-18

DSK DSK

DSK DSK

BY CHK'E

**REVISIONS** 

PEER REVIEW COMMENTS

POTENTIAL WETLAND

DESCRIPTION

2 |08/08/18|

1 07/19/18

DWG. No. 6108\_PILOT-DET NO. DATE

# 43 ESTABROOK AVENUE

SITE DETAILS LOCATED IN GRAFTON, MASSACHUSETTS

(WORCESTER COUNTY)

PREPARED FOR ESTABROOK VALLEY, LLC SCALE: AS NOTED DATE: JUNE 26, 2018



SHEET No. 5 OF 5

BEVERLY, MASSACHUSETTS 01915 WESTBOROUGH, MASSACHUSETTS 01581 TELEPHONE: (508) 871-7030

DECAL TO BOTH SIGNS A AND B.

DWG FILE: 6108\_PILOT-DET.dwg 11:24am PLOTTED: Aug 08, 2018 dkelley

PROJECT No. 6108